L. Roberto Lomas P.E.

Engineering Evaluation Report

233 W. Main St Danville, VA 24541 434-688-0609 rllomas@lrlomaspe.com

Report No.: 512499

Manufacturer: US Aluminum Inc.

720 Cel-River Road Rock Hill, SC 29730

Product Line: Series 450 Center Glazed Store Front

Compliance:

The above mentioned product has been evaluated for compliance with the requirements of the Florida Department of Community Affairs for Statewide Acceptance per Rule 9N-3.005 method 1(d). The product listed herein complies with requirements of the Florida Building Code.

Supporting Technical Documentation:

- 1. Approval document: drawing number 08-01813, titled Series 450 Center Glazed Store Front, prepared, signed and sealed by Luis Roberto Lomas P.E.
- 2. Test report No.: ATI 79428.03-801-47 signed and sealed by Joseph Reed, P.E.

Architectural Testing Inc., Southlake, TX

ASTM E330-02 Design pressure ±30.0psf

Water penetration: 8.0psf


3. Anchor calculations, report number 512499-1, prepared, signed and sealed by Luis Roberto Lomas P.E.

Limitations and Conditions of use:

- Maximum design pressure: ±30.0psf (Refer to Installation Instruction for smaller sizes rating)
- Units must be glazed per ASTM E1300-04, see installation instructions for glass options.
- This product is not rated to be used in the HVHZ.
- This product is not impact resistant and requires impact protection in wind borne debris regions.
- Frame material to be extruded Aluminum 6063-T5.

Installation: Units must be installed in accordance with approval document, 08-01813.

Certification of Independence: Please note that I don't have nor will acquire a financial interest in any company manufacturing or distributing the product(s) for which this report is being issued. Also, I don't have nor will acquire a financial interest in any other entity involved in the approval process of the listed product(s).

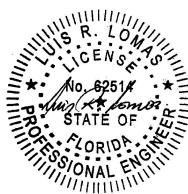

Luis R. Lomas, P.E. FL No.: 62514 10/22/2012

REVISIONS

REV DESCRIPTION DATE APPROVED

NOTES:

- 1. THE PRODUCT SHOWN HEREIN IS DESIGNED AND MANUFACTURED TO COMPLY WITH REQUIREMENTS OF THE FLORIDA BUILDING CODE.
- 2. WOOD FRAMING AND MASONRY OPENING TO BE DESIGNED AND ANCHORED TO PROPERLY TRANSFER ALL LOADS TO STRUCTURE. FRAMING AND MASONRY OPENING IS THE RESPONSIBILITY OF THE ARCHITECT OR ENGINEER OF RECORD.
- 3. 1X BUCK OVER MASONRY/CONCRETE IS OPTIONAL. WHERE 1X BUCK IS NOT USED DISSIMILAR MATERIALS MUST BE SEPARATED WITH APPROVED COATING OR MEMBRANE. SELECTION OF COATING OR MEMBRANE IS THE RESPONSIBILITY OF THE ARCHITECT OR ENGINEER OF RECORD.
- 4. ALLOWABLE STRESS INCREASE OF 1/3 WAS NOT USED IN THE DESIGN OF THE PRODUCT SHOWN HEREIN. WIND LOAD DURATION FACTOR Cd=1.6 WAS USED FOR WOOD ANCHOR CALCULATIONS.
- 5. FRAME MATERIAL: EXTRUDED ALUMINUM 6063-T5
- 6. UNITS MUST BE GLAZED PER ASTM E1300-04, WITH TEMPERED GLASS.
- 7. APPROVED IMPACT PROTECTIVE SYSTEM <u>IS REQUIRED</u> FOR THIS PRODUCT IN WIND BORNE DEBRIS REGIONS.
- 8. SHIM AS REQUIRED AT EACH INSTALLATION ANCHOR WITH LOAD BEARING SHIM. SHIM WHERE SPACE OF 1/16" OR GREATER OCCURS. MAXIMUM ALLOWABLE SHIM STACK TO BE 1/2".
- 9. FOR ANCHORING INTO WOOD FRAMING OR 2X BUCK USE #12 WOOD SCREWS WITH SUFFICIENT LENGTH TO ACHIEVE A 1 5/8" MINIMUM EMBEDMENT INTO SUBSTRATE. LOCATE ANCHORS AS SHOWN IN ELEVATIONS AND INSTALLATION DETAILS.
- 10. FOR ANCHORING INTO MASONRY/CONCRETE USE 1/4" TAPCONS WITH SUFFICIENT LENGTH TO ACHIEVE A 1 1/4" MINIMUM EMBEDMENT INTO SUBSTRATE WITH 2 1/2" MINIMUM EDGE DISTANCE. LOCATE ANCHORS AS SHOWN IN ELEVATIONS AND INSTALLATION DETAILS.
- 11. FOR ANCHORING INTO METAL STRUCTURE USE #12 SMS OR SELF DRILLING SCREWS WITH SUFFICIENT LENGTH TO ACHIEVE 3 THREADS MINIMUM BEYOND STRUCTURE INTERIOR WALL. LOCATE ANCHORS AS SHOWN IN ELEVATIONS AND INSTALLATION DETAILS.
- 12. ALL FASTENERS TO BE CORROSION RESISTANT.
- 13. INSTALLATION ANCHORS SHALL BE INSTALLED IN ACCORDANCE WITH ANCHOR MANUFACTURER'S INSTALLATION INSTRUCTIONS AND ANCHORS SHALL NOT BE USED IN SUBSTRATES WITH STRENGTHS LESS THAN THE MINIMUM STRENGTH SPECIFIED BELOW:
 - A. WOOD MINIMUM SPECIFIC GRAVITY OF G=0.42
 - B. CONCRETE MINIMUM COMPRESSIVE STRENGTH OF 3,192 PSI.
 - C. MASONRY STRENGTH CONFORMANCE TO ASTM C-90, GRADE N, TYPE 1 (OR GREATER).

TABLE OF CONTENTS

DESCRIPTION

D. METAL STRUCTURE: STEEL 18GA, 33KSI OR ALUMINUM 6063-T5 1/8" THICK MINIMUM

SHEET NO.

1

3 - 5

NOTES

ELEVATION. AND CHART

INSTALLATION DETAILS

SIGNED: 10/09/2012

US ALUMINUM INC. 720 CEL-RIVER ROAD ROCK HILL, SC 29730

SERIES 450 CENTER GLAZE STORE FRONT NOTES

DRAWN: DWG NO. 08-01

SCALE NTS


08-01813

DATE 10/08/12 SHEET 1 OF 5



REVISIONS

REV DESCRIPTION DATE APPROVED

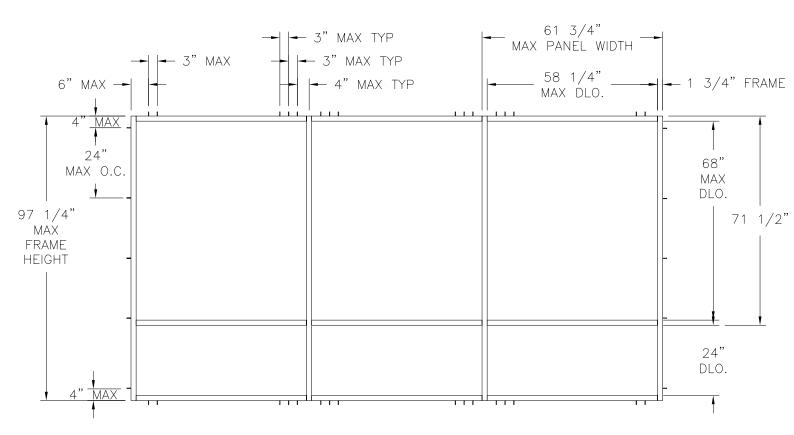

SERIES 450 CENTER GLAZE STORE FRONT

EXTERIOR VIEW

UNLIMITED NUMBER OF PANELS IN UNLIMITED CONFIGURATION ARE APPROVED AS LONG AS INDIVIDUAL PANEL SIZE DOES NOT EXCEED MAXIMUM PANEL SIZE AND USES VERTICAL CONDITIONS AS SHOWN.

DESIGN PRESSURE RATING	IMPACT RATING					
±30.0PSF	NONE					


Maximum design pressure capacity chart (psf)																
Frame		Single Panel Width (in)														
Height	24.00		30.00		36.00		42.00		48.00		54.00		60.00		61.75	
(in)	Pos	Neg	Pos	Neg	Pos	Neg	Pos	Neg	Pos	Neg	Pos	Neg	Pos	Neg	Pos	Neg
24.00	53.3	60.0	53.3	60.0	53.3	60.0	53.3	60.0	53.3	60.0	53.3	60.0	53.3	60.0	53.3	60.0
30.00	53.3	60.0	53.3	60.0	53.3	60.0	53.3	60.0	53.3	60.0	53.3	60.0	53.3	60.0	53.3	60.0
36.00	53.3	60.0	53.3	60.0	53.3	60.0	53.3	60.0	53.3	60.0	53.3	60.0	53.3	60.0	53.3	60.0
42.00	53.3	60.0	53.3	60.0	53.3	60.0	53.3	60.0	53.3	60.0	53.3	60.0	53.3	60.0	53.3	60.0
48.00	53.3	60.0	53.3	60.0	53.3	60.0	53.3	60.0	53.3	60.0	53.3	60.0	53.3	60.0	53.3	60.0
54.00	53.3	60.0	53.3	60.0	53.3	60.0	53.3	60.0	53.3	60.0	53.3	60.0	53.3	60.0	53.3	60.0
60.00	53.3	60.0	53.3	60.0	53.3	60.0	53.3	60.0	53.3	60.0	53.3	60.0	53.3	60.0	53.3	60.0
66.00	53.3	60.0	53.3	60.0	53.3	60.0	53.3	60.0	53.3	60.0	53.3	58.4	53.3	56.9	53.3	56.7
72.00	53.3	60.0	53.3	60.0	53.3	60.0	53.3	57.4	53.3	53.4	50.6	50.6	48.8	48.8	48.4	48.4
78.00	53.3	60.0	53.3	60.0	53.3	56.9	51.4	51.4	47.4	47.4	44.6	44.6	42.7	42.7	42.3	42.3
84.00	53.3	60.0	53.3	59.4	51.8	51.8	46.5	46.5	42.7	42.7	39.9	39.9	38.0	38.0	37.5	37.5
90.00	53.3	60.0	53.3	54.6	47.4	47.4	42.4	42.4	38.8	38.8	36.1	36.1	34.2	34.2	33.7	33.7
96.00	53.3	60.0	50.6	50.6	43.8	43.8	39.0	39.0	35.6	35.6	33.0	33.0	31.1	31.1	30.6	30.6
97.25	53.3	60.0	49.8	49.8	43.1	43.1	38.4	38.4	35.0	35.0	32.4	32.4	30.5	30.5	30.0	30.0


US ALUMINUM INC. 720 CEL-RIVER ROAD ROCK HILL, SC 29730

SERIES 450 CENTER GLAZE STORE FRONT ELEVATION, AND CHART


DRAWN: DWG NO. REV — SCALE NTS DATE 10/08/12 SHEET 2 OF 5



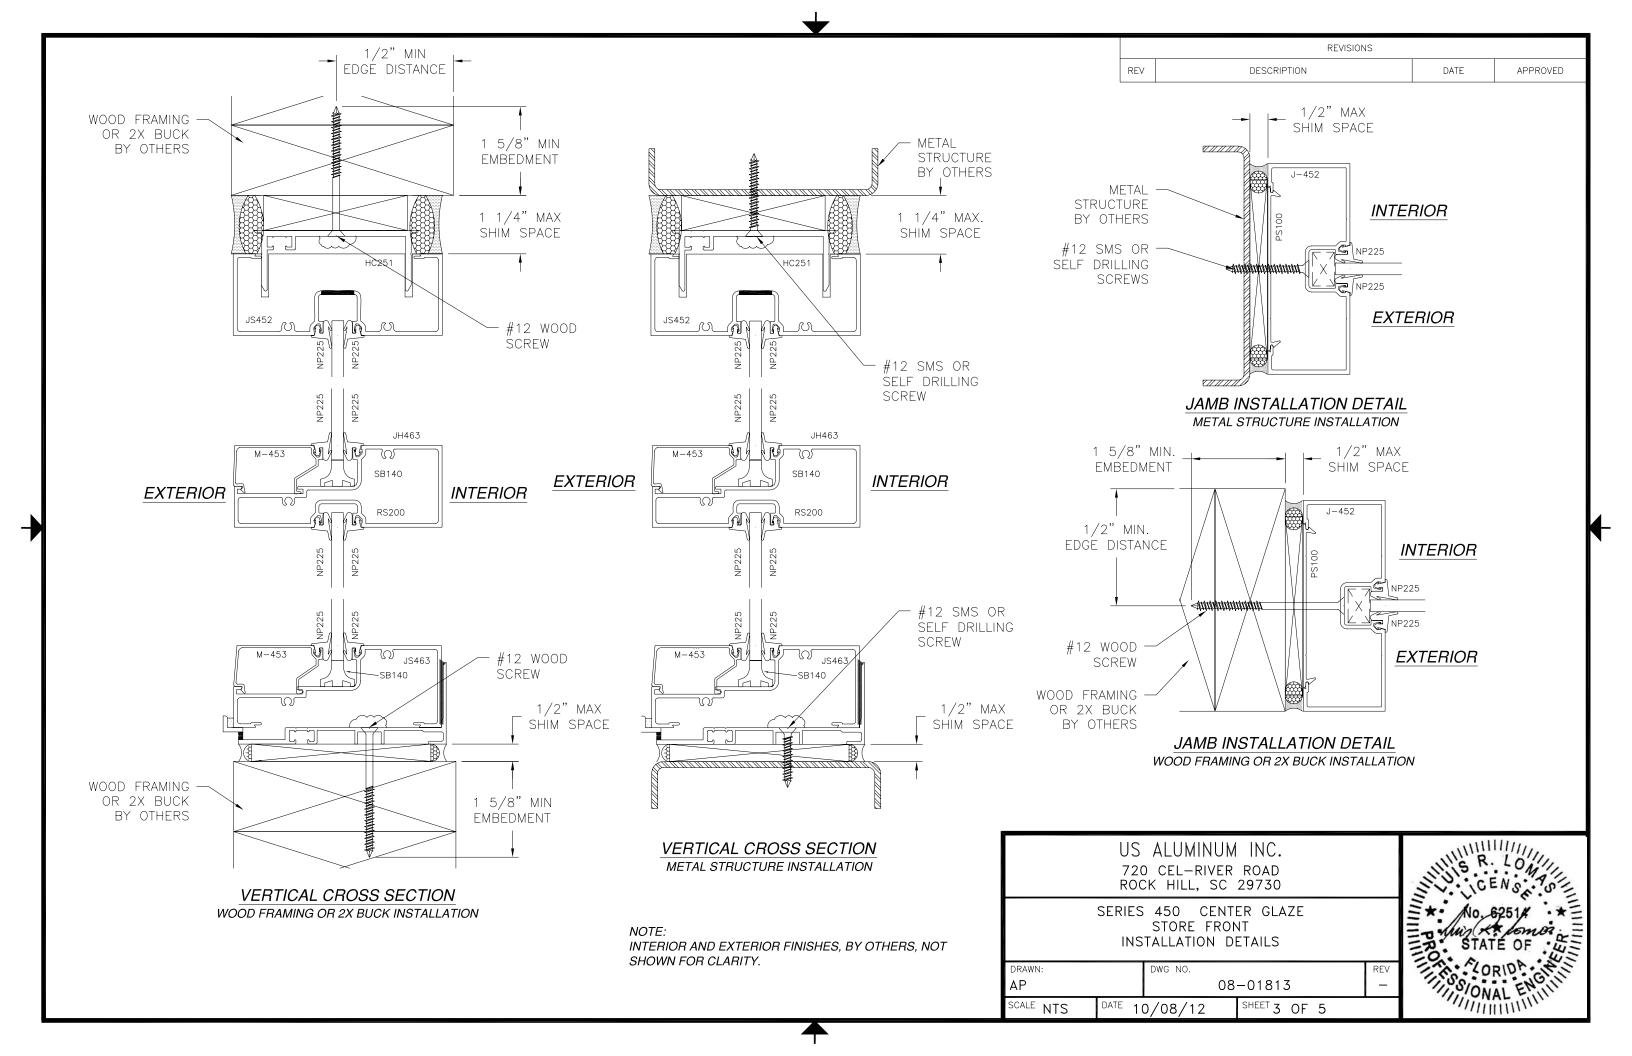


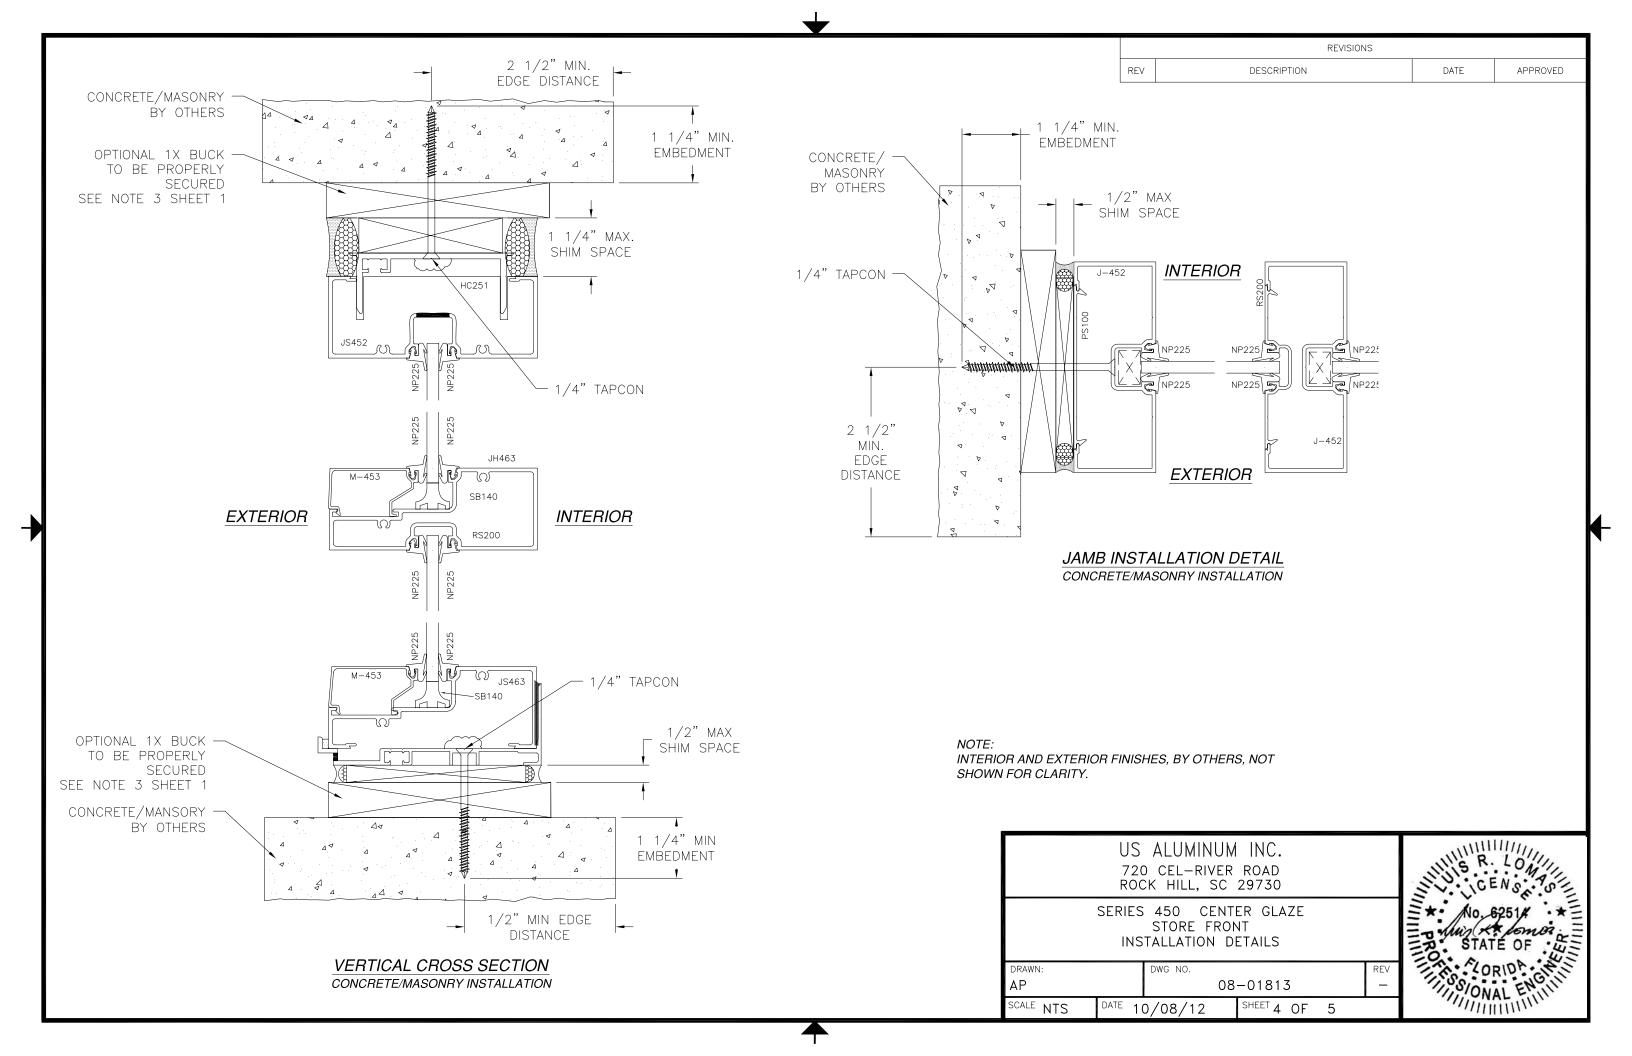




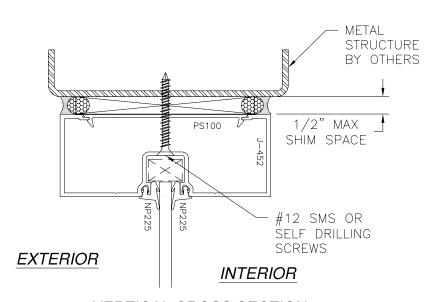

VERTICAL CROSS SECTION
WOOD FRAMING OR 2X BUCK INSTALLATION
OPTIONAL HEAD CONFIGURATION

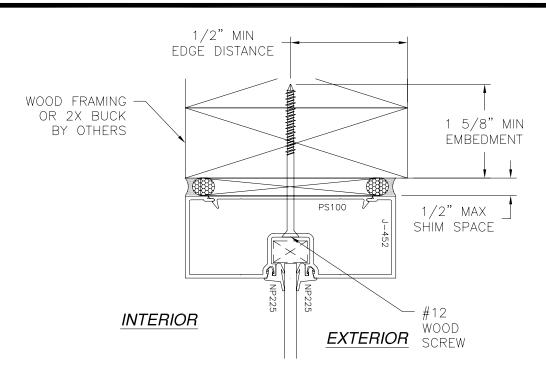

VERTICAL CROSS SECTION WOOD FRAMING OR 2X BUCK INSTALLATION OPTIONAL HEAD CONFIGURATION

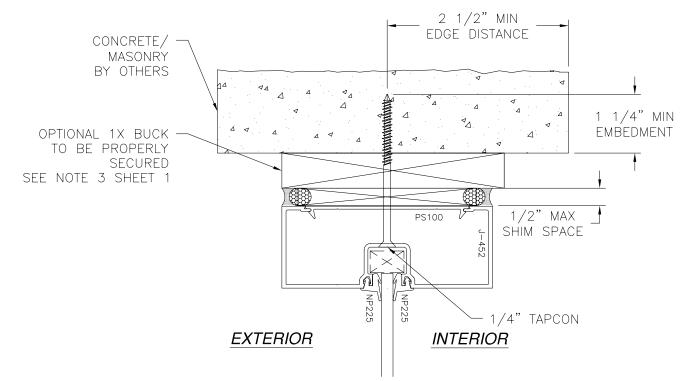

VERTICAL CROSS SECTION WOOD FRAMING OR 2X BUCK INSTALLATION OPTIONAL HEAD CONFIGURATION

NOTE: INTERIOR AND EXTERIOR FINISHES, BY OTHERS, NOT SHOWN FOR CLARITY.

US 720 ROC	CENSON TO		
SERIES INS	No. 6251# *=		
DRAWN:	DWG NO.	REV	CORION
AP	08-018	MONONAL ENGLIS	
SCALE NTS DATE 10	0/08/12 SHEET	5 OF 5	Milling